SCS PROJECT: WINDOWSHIELD STANDARD TEMPLATE



ATTENTION: TECHNICAL REQUIREMENTS FOR THIS PROJECT



| No | DESCRIPTION | REQUIREMENT | RESPONSIBILITY |
|----|--------------------|---|---------------------|
| 1 | WORKS DONE | ALL DETAILS PERTAINING TO WORK BY OTHERS IS AN ADVISEMENT ONLY AND IT IS THE | BUILDER, ARCHITECT, |
| | BY OTHERS | RESPONSIBILITY OF THE SUPPLIER AND INSTALLER OF THE ITEM/S TO CONFIRM COMPLIANCE TO ITS SUITABILITY FOR THE PURPOSE AND TO CERTIFY ITS COMPLIANCE TO THE REQUIRED FRL | OTHER TRADES |
| | | TO THE SATISFACTION OF THE FE OR CERTIFIER. | |
| 2 | SHOP DRAWINGS | APPROVAL OF SHOP DRAWINGS (SIGNITURE AND DATE) IS REQUIRED TO BE | BUILDER, ARCHITECT |
| | | RETURNED TO SMOKE CONTROL SYSTEMS BEFORE MANUFACTURE CAN COMMENCE. | - |
| 3 | DELIVERIES TO SITE | IF REQD, FORKLIFT TO BE MADE AVAILABLE. | BUILDER |
| 4 | VERTICAL MOVEMENT | IF REQD, CRANE SHALL BE AVAILABLE TO SMOKE CONTROL SYSTEMS AT AGREED TIME | BUILDER |
| | OF PRODUCT | OF DELIVERY. IF THIS IS NOT AVAILABLE, THIS MAY INCUR EXTRA CHARGES. | |
| 5 | STORAGE | SUFFICIENT CLEAR FLOOR SPACE TO BE MADE AVAILABLE IMMEDIATELY ADJACENT TO | BUILDER |
| | | EACH INSTALLATION LOCATION. | |
| 6 | ACCESS TO WORKFACE | ADEQUATE WORKING AREA REQD., MIN 500mm FROM SYSTEM TO STRUCTURE IS | BUILDER |
| | (INSTALLATION) | IDEAL. SUBJECT TO SITE CONDITIONS. | |
| 7 | ACTIVATION | WINDOWSHIELDS ARE ACTIVATED VIA A MECAHNICAL FUSIBLE LINK. | SMOKE CONTROL |
| | | | SYSTEMS |
| 8 | CERTIFICATON | WITNESS TESTING, FINAL COMMISSIONING & HANDOVER | SMOKE CONTROL |
| | | | SYSTEMS |
| | | | |

| | DRAWING INDEX | | | | |
|-------|-------------------------------------|-----|--|--|--|
| SHEET | DESCRIPTION | REV | | | |
| | 00 - SPECIFICATIONS | | | | |
| 0001 | COVER SHEET | - | | | |
| | 01 - BOUNDARY CONTROL | | | | |
| 0101 | BOUNDARY CONTROL - FRONT ELEVATION | - | | | |
| 0102 | BOUNDARY CONTROL - CLOSE UP DETAILS | - | | | |
| | 02 - FLAME ZONE | | | | |
| 0201 | FLAME ZONE - FRONT ELEVATION | - | | | |
| 0202 | FLAME ZONE - CLOSE UP DETAIL | - | | | |

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| W W | CHK | REASON | DATE | | |
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| 1 | AC | RELEASED | 07/09/2020 | | |
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PROJECT SCS-WS

WINDOWSHIELD STANDARD TEMPLATE

CLIENT

COVER SHEET

04/09/2020

SUB SET (CATEGORY)

00 - SPECIFICATIONS DRAWING NUMBER

SCS-WS-0001 ISSUE STATUS: FOR INFORMATION DRAWN BY START DATE SCALE AS SHOWN

REV


@**A**2 5

<<< 594mm

GALVANISED STEEL HEAD BOX HEAD BOX & BOTTOM BAR POWDER COATING TO DULUX DURALLOY COLOURS IS INCLUDED. OTHER -/60/-WINDOWSHIELD NON-STANDARD COLOURS OR GRADES WILL INCUR AN EXTRA CHARGE SIDE GUIDES SIDE GUIDES **GALVANISED STEEL** UNLESS STATED OR AGREED UPON OTHERWISE. FIRE SHUTTER AS1530.4 WILL COME IN RAW FINISH IF COLOUR IS NOT PROVIDED BY CLIENT **FABRIC** 1100°C RATED **BOTTOM BAR MATERIALS COLOUR/FINISH SYSTEM** COMPONENT **FRL** PRODUCT SPECIFICATIONS

NOTES:

- WINDOW/DOOR SIZES ARE NOMINAL
- MAXIMUM WINDOW/DOOR OPENING IS 2.7m WIDE x 2.5m HIGH. ANY WINDOWS/DOORS ABOVE THESE DIMENSIONS WILL BE REQUIRED TO BE MOTORISED FYREHALT SYSTEMS.
- AWNING TYPE WINDOWS AND DOORS MUST OPEN AWAY FROM WARRIOR SYSTEM. WHERE AWNING TYPE WINDOW OPEN IN DIRECTION OF WINDOWSHIELD THEY MUST BE RESTRICTED TO PREVENT BLOCKING DEPLOYMENT. WHERE DOORS OPEN IN THE DIRECTION OF THE WINDOWSHIELD THEY MUST BE FITTED WITH AN AUTOCLOSER.

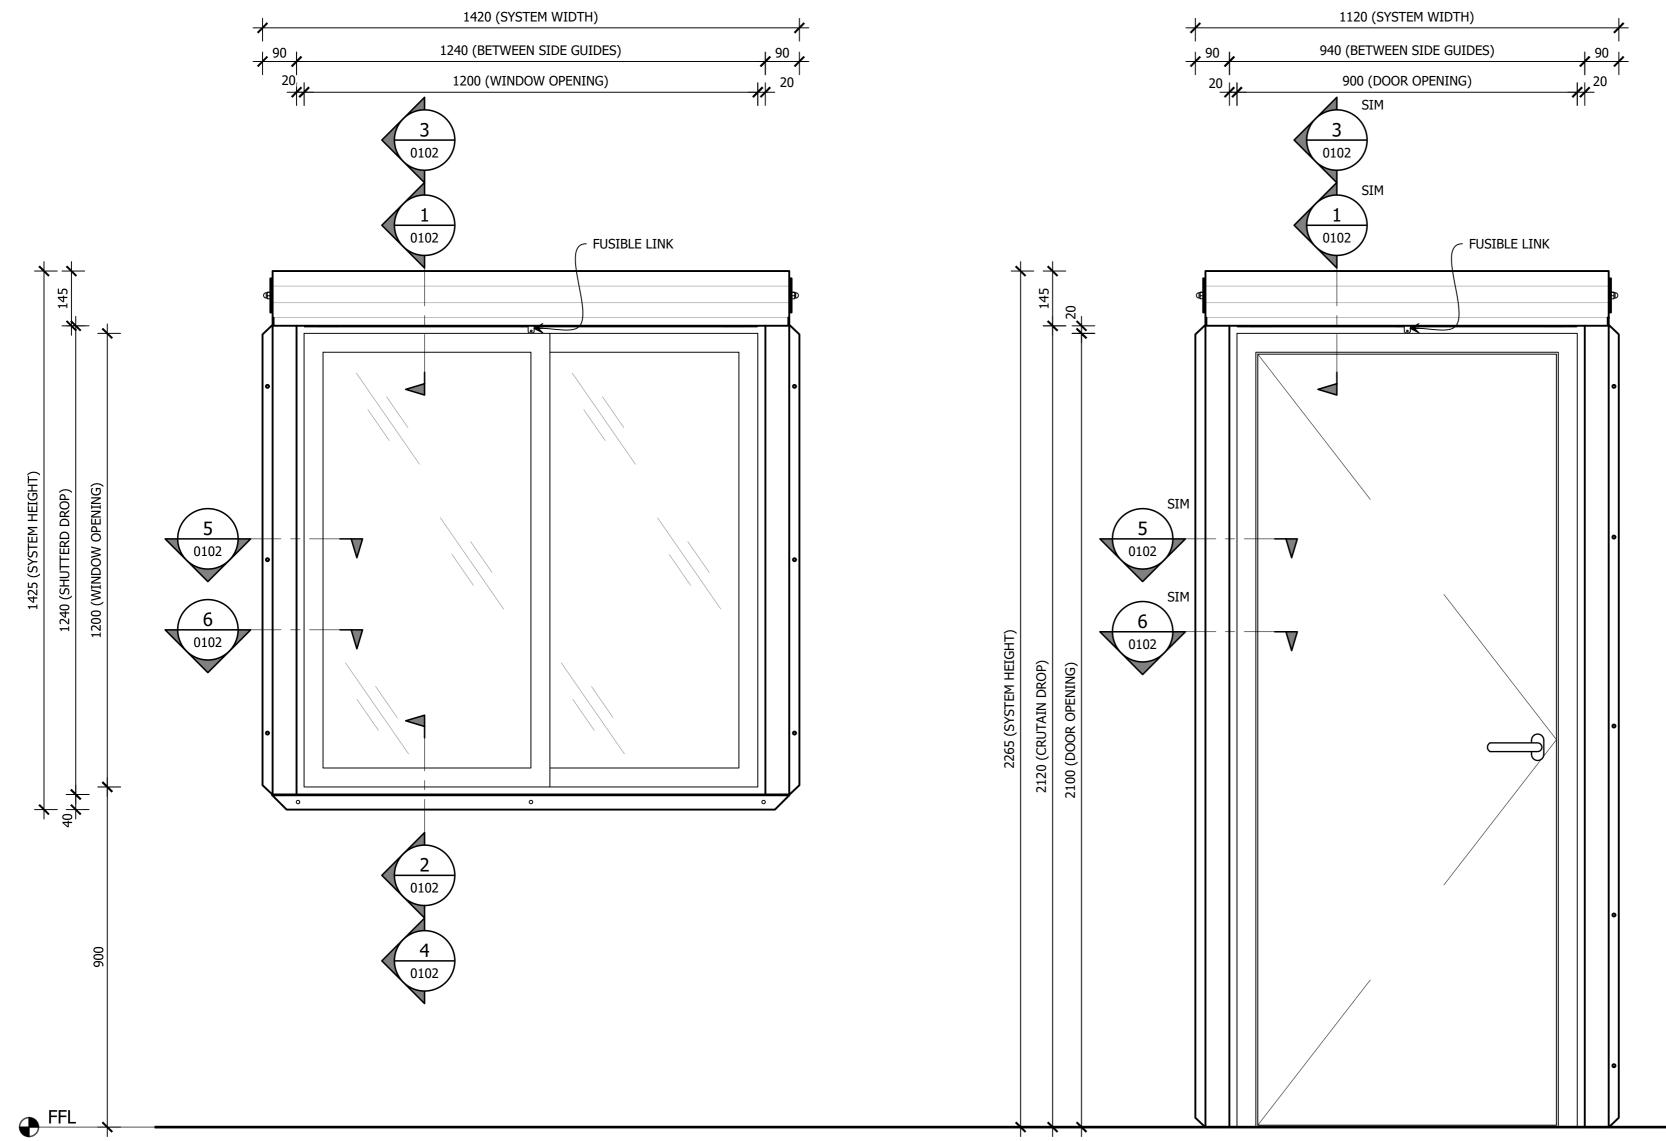

FRONT ELEVATION - VIEW FROM OUTSIDE WINDOWSHIELD OVER WINDOW SCALE 1:10 @ A2

FRONT ELEVATION - VIEW FROM OUTSIDE WINDOWSHIELD OVER DOOR SCALE 1:10 @ A2

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| δ _{6γ} | CHK | REASON | DATE | | | |
| - | AC | RELEASED | 07/09/2020 | | | |

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PROJECT SCS-WS

CLIENT

FRONT ELEVATION OVER WINDOW & DOOR BOUNDARY CONTROL

SUB SET (CATEGORY)


01 - BOUNDARY CONTROL DRAWING NUMBER

SCS-WS-0101

ISSUE STATUS: FOR INFORMATION DRAWN BY

START DATE SCALE AS SHOWN 04/09/2020

REV

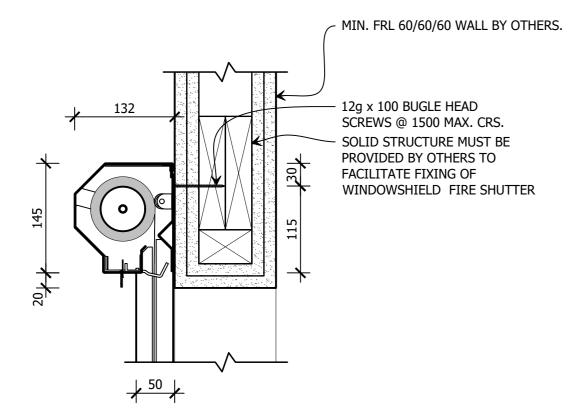



M8 x 50 DYNABOLTS @ 1500 MAX. CRS. ALL FLASHING/WEATHERPROOFING MUST BE DONE BY OTHERS

MIN. FRL 60/60/60 WALL BY OTHERS.

1 ELEVATION HEAD BOX DETAIL INTO STUD WALL SCALE 1:5 @ A2


3 HEAD BOX DETAIL INTO MASONRY WALL SCALE 1:5 @ A2

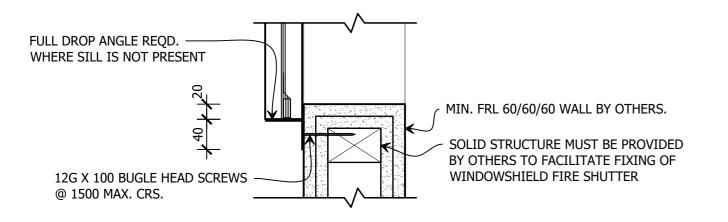


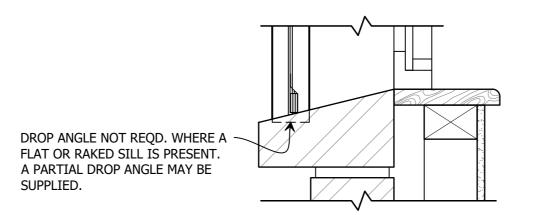

2 SCALE 1:5 @ A2

4 SCALE 1:5 @ A2 ELEVATION
SILL DETAIL INTO MASONRY WALL

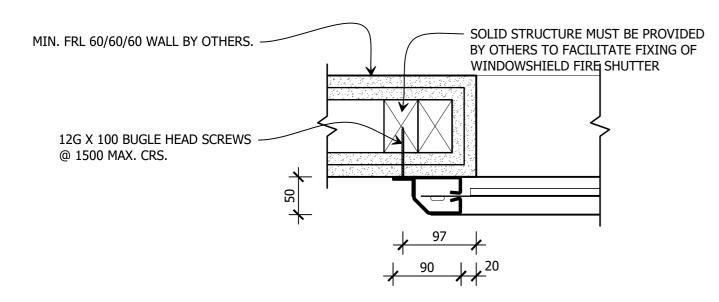

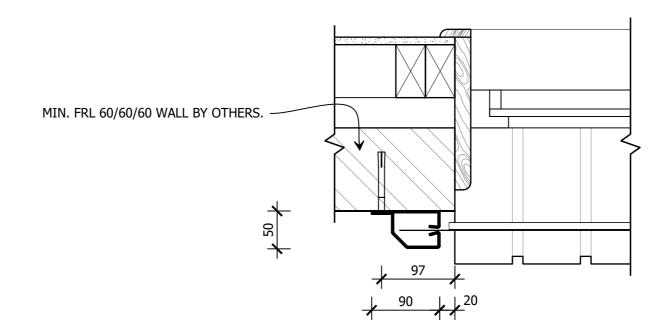

5 PLAN SIDE GUIDE DETAIL INTO STUD WALL
SCALE 1:5 @ A2

6 SIDE GUIDE DETAIL INTO MASONRY WALL
SCALE 1:5 @ A2

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PROJECT

SCS-WS

WINDOWSHIELD STANDARD TEMPLATE

CLIENT

TITLE

CLOSE UP DETAILS STUD & MASONRY WALLS BOUNDARY CONTROL

SUB SET (CATEGORY)

01 - BOUNDARY CONTROLDRAWING NUMBER

SCS-WS-0102

DRAWN BY
I.A.

START DATE
04/09/2020

ISSUE STATUS:
FOR INFORMATION
SCALE
AS SHOWN @A2


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| - | AC | RELEASED | 07/09/2020 | | |



FRONT ELEVATION - VIEW FROM OUTSIDE WARRIOR OVER WINDOW SCALE 1:10 @ A2

FRONT ELEVATION - VIEW FROM OUTSIDE WARRIOR OVER DOOR SCALE 1:10 @ A2

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SCS-WS

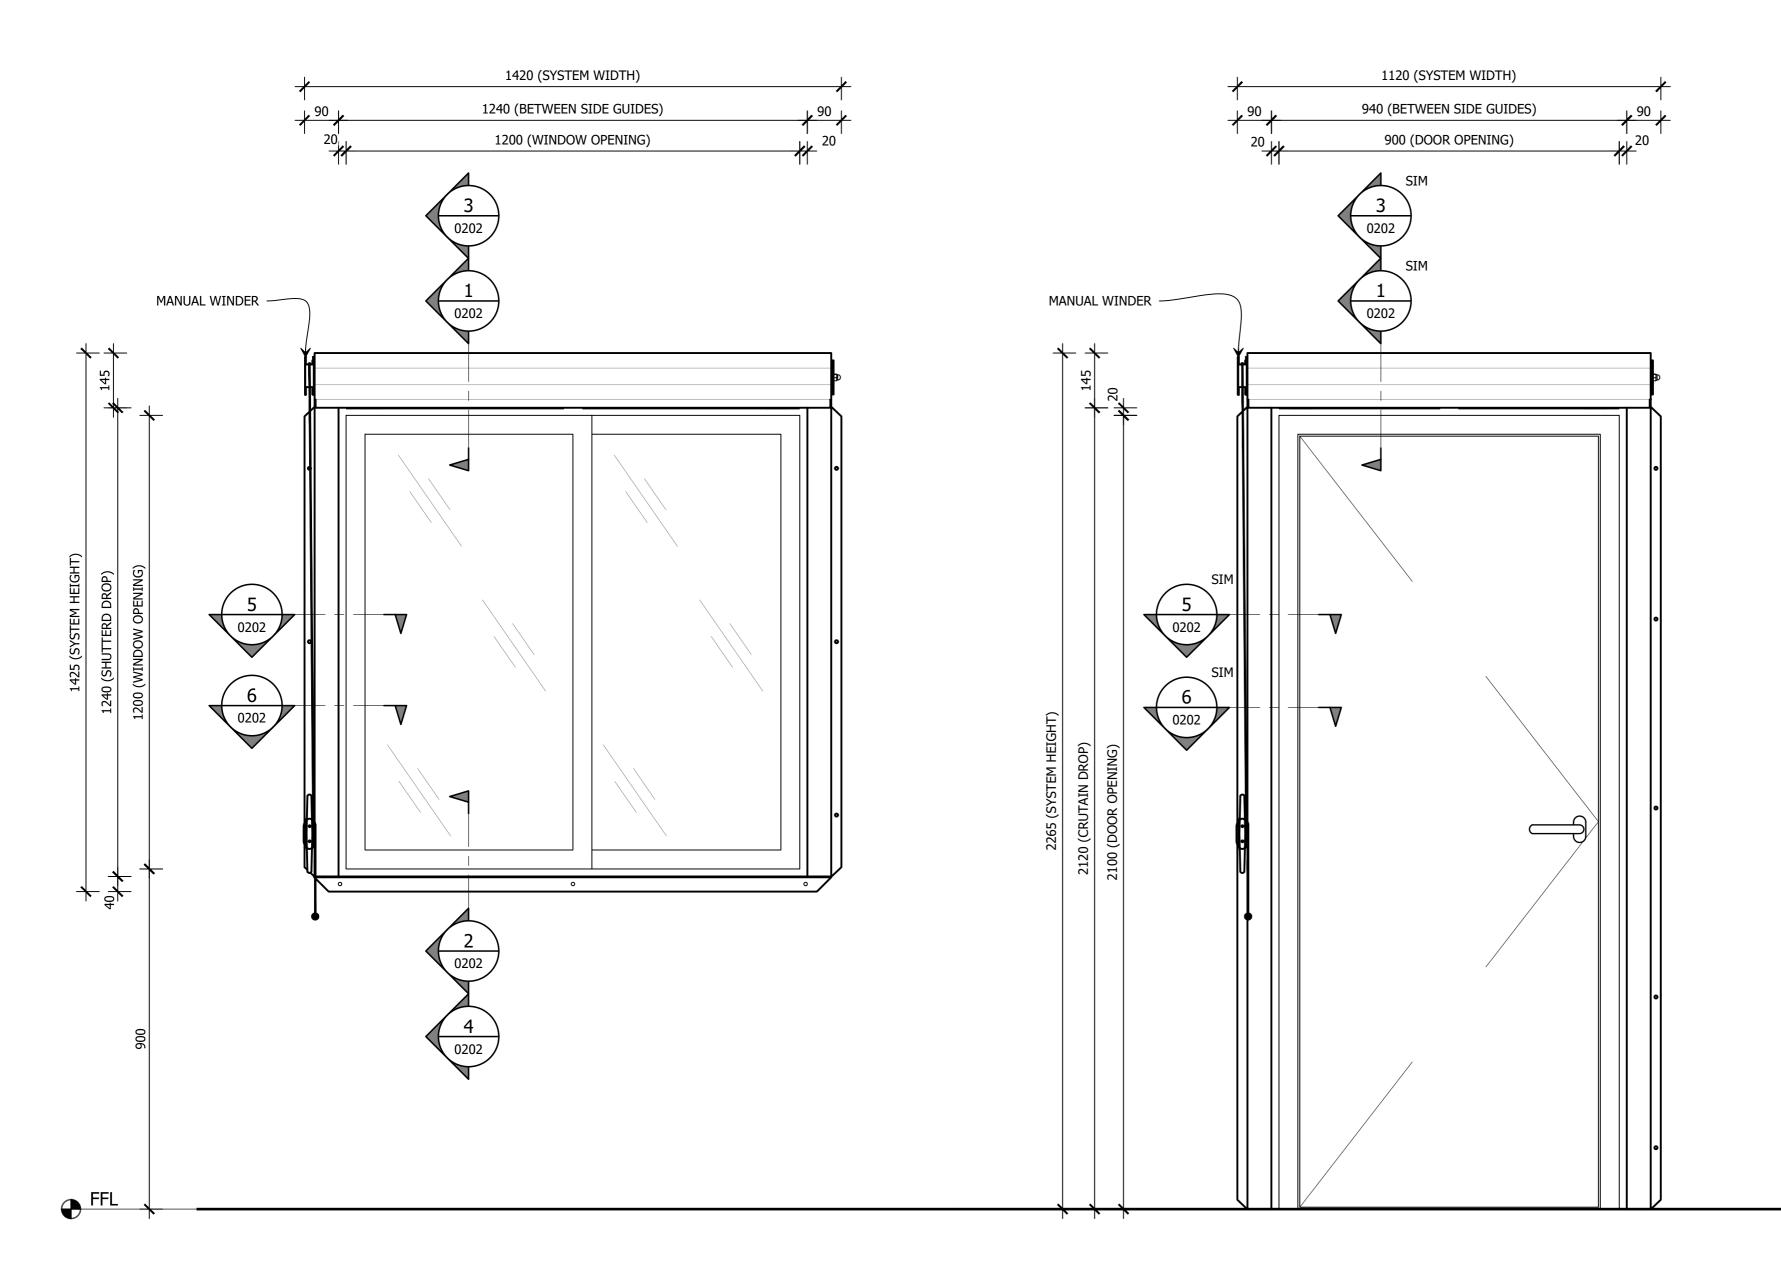CLIENT

FRONT ELEVATION FLAME ZONE

SUB SET (CATEGORY)


02 - FLAME ZONE

DRAWING NUMBER


SCS-WS-0201 DRAWN BY

ISSUE STATUS: FOR INFORMATION SCALE AS SHOWN START DATE @**A**2 5 04/09/2020

REV

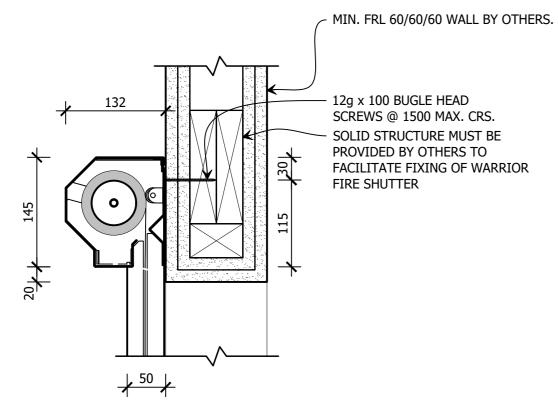

ELEVATION HEAD BOX DETAIL INTO STUD WALL

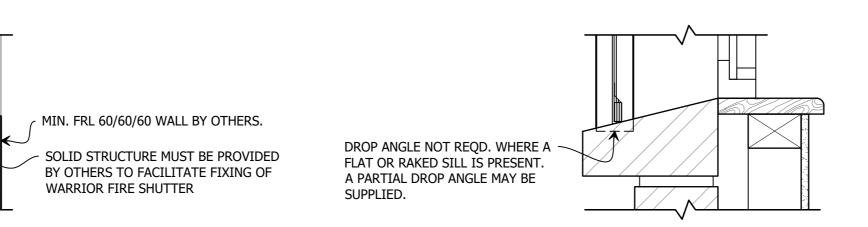

132

0

ELEVATION

ELEVATION SILL DETAIL INTO STUD WALL

FULL DROP ANGLE REQD. WHERE SILL IS NOT PRESENT

@ 1500 MAX. CRS.

12G X 100 BUGLE HEAD SCREWS


ELEVATION SILL DETAIL INTO MASONRY WALL SCALE 1:5 @ A2

HEAD BOX DETAIL INTO MASONRY WALL

MIN. FRL 60/60/60 WALL BY OTHERS. M8 x 50 DYNABOLTS @ 1500 MAX. CRS.

ALL FLASHING/WEATHERPROOFING

MUST BE DONE BY OTHERS

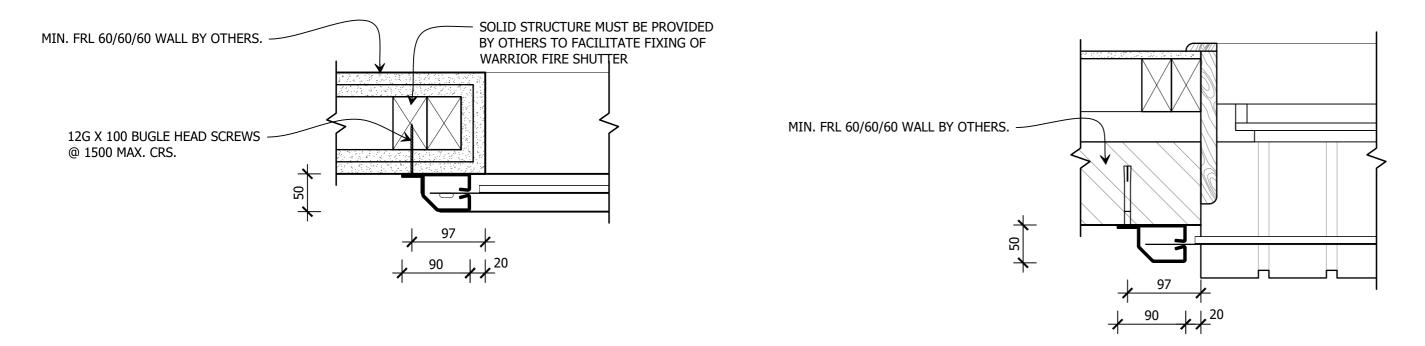

SIDE GUIDE DETAIL INTO STUD WALL
SCALE 1:5 @ A2

PLAN SIDE GUIDE DETAIL INTO MASONRY WALL SCALE 1:5 @ A2

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PROJECT

SCS-WS WINDOWSHIELD STANDARD TEMPLATE

CLIENT

CLOSE UP DETAILS STUD & MASONRY WALLS IFLAME ZONE

SUB SET (CATEGORY)

02 - FLAME ZONE DRAWING NUMBER

SCS-WS-0202

ISSUE STATUS: FOR INFORMATION DRAWN BY START DATE SCALE AS SHOWN 04/09/2020

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