## **SCS PROJECT - FS4** FIBERSHIELD 4



## ATTENTION: TECHNICAL REQUIREMENTS FOR THIS PROJECT



No	DESCRIPTION	REQUIREMENT	RESPONSIBILITY
1	WORKS DONE BY OTHERS	ALL DETAILS PERTAINING TO WORK BY OTHERS IS AN ADVISEMENT ONLY AND IT IS THE RESPONSIBILITY OF THE SUPPLIER AND INSTALLER OF THE ITEM/S TO CONFIRM COMPLIANCE TO ITS SUITABILITY FOR THE PURPOSE AND TO CERTIFY ITS COMPLIANCE TO THE REQUIRED FRL TO THE SATISFACTION OF THE FE OR CERTIFIER.	BUILDER, ARCHITECT, OTHER TRADES
2	SHOP DRAWINGS	APPROVAL OF SHOP DRAWINGS (SIGNITURE AND DATE) IS REQUIRED TO BE RETURNED TO SMOKE CONTROL SYSTEM BEFORE MANUFACTURE CAN COMMENCE.	BUILDER, ARCHITECT
3	DELIVERIES TO SITE	IF REQD, FORKLIFT TO BE MADE AVAILABLE.	BUILDER
4	VERTICAL MOVEMENT OF PRODUCT	IF REQD, CRANE SHALL BE AVAILABLE TO SMOKE CONTROL SYSTEMS AT AGREED TIME OF DELIVERY. IF THIS IS NOT AVAILABLE, THIS MAY INCUR EXTRA CHARGES.	BUILDER
5	STORAGE	SUFFICIENT CLEAR FLOOR SPACE TO BE MADE AVAILABLE IMMEDIATELY ADJACENT TO EACH INSTALLATION LOCATION.	BUILDER
6	ACCESS TO WORKFACE (INSTALLATION)	REASONABLY ADEQUATE WORKING AREA REQD., MIN 500mm FROM SYSTEM TO STRUCTURE IS IDEAL. SUBJECT TO SITE CONDITIONS.	BUILDER
7	BALUSTRADES (WHERE PRESENT)	WHERE APPLICABLE, BALLUSTRADES MUST NOT INTERFERE WITH THE OPERATION OF CURTAIN IN ANY WAY. MIN. 100mm FROM SYSTEM TO BALUSTRADE OFFSET IS IDEAL.	BUILDER
8	ACCESS PANELS (INSTALATION WITHIN CEILING CAVITY)	450X450 NOM. ACCESS PANELS TO BE PROVIDED. THREE EQUALY SPACED PANELS (ONE ON EITHER END AND ONE DEAD CENTRE) WILL BE REQUIRED WHERE ACCESS TO HEAD BOX IS RESTRICTED.  MAY NOT BE REQD. WHERE REMOVABLE GRID CEILING ALLOWS FOR CLEAR ACCESS TO CURTAIN CONTROLLERS.	BUILDER, CEILING CONTRACTOR
9	POWER REQUIREMENTS	240 VOLT 10 AMP GPO TO BE LOCATED NO MORE THAN 1m AWAY FROM NOMINATED LOCATION OF CURTAIN CONTROLLERS.	BUILDER, ELECTRICAL
10	ALARM SIGNAL, ACTIVATION	0 VOLT NORMALLY CLOSED CONTACT (OPEN ON ALARM) TO BE PROVIDED WITHIN 1 METRE OF CURTAIN CONTROLLER.	BUILDER, ELECTRICAL, FIRE
11	PRESSURISATION, EXHAUST SYSTEMS	IMPORTANT: BALANCING TO CONSIDER AFFECTS OF CURTAINS 20 PA MAX. PRESSURE DIFFERENTIAL STRONGLY RECOMMENDED.	BULDER, MECHANICAL SERVICES
12	TUNING	ALL SCAFFOLDING & OTHER TRADES TO BE CLEAR 2 DAYS PRIOR TO TUNING & COMMISSIONING.	BUILDER
13	COMMISSIONING STAGE 1	PRACTICAL COMPLETION TESTS: PERMANENT POWER & ALARMS CONNECTED FOR DRY RUN PRIOR TO CSC. CURTAINS MUST BE ISOLATED DURING INDIVIDUAL COMMISSIONING OF OTHER ESSENTIAL SERVICES.  (PRODUCT LOCKED IN OPEN POSITION AFTER TESTING)	SMOKE CONTROL SYSTEMS & BUILDER
14	COMMISSIONING STAGE 2	COORDINATED SERVICES COMMISSIONING (CSC)	SMOKE CONTROL SYSTEMS
15	COMMISSIONING STAGE 3	WITNESS TESTING, FINAL COMMISSIONING & HANDOVER	SMOKE CONTROL SYSTEMS
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DRAWING INDEX				
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0002	3D INDICATIVE VIEW	-		
0003	FRONT ELEVATION	-		
0004	SIDE ELEVATION - HEAD BOX MOUNTING OPTIONS	-		
0005	PLAN VIEW - SIDE GUIDE MOUNTING OPTIONS	-		
0006	CORNER POST DETAIL	-		
0007	BOTTOM BAR OPTIONS	-		
0008	OBSTRUCTION SENSORS	-		

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W W	CHK	REASON	DATE
1	AC	FOR INFORMATION	27/05/2020

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336 SETTLEMENT RD THOMASTOWN VIC 3074 PROJECT

PHONE: 0417 657 623

VICTORIA OFFICE

**NEW ZEALAND** PHONE: 09 300 1980 LEVEL 4, 369 QUEEN ST AUCKLAND NZ 1010

FIBERSHIELD 4 CLIENT

TITLE COVER SHEET

SUB SET (CATEGORY) 00 - TEMPLATE


DRAWING NUMBER

FS4-0001 DRAWN BY ISSUE STATUS: ISHTIAQUE ALAM INFORMATION SCALE AS SHOWN @A2 & START DATE 27/05/2020

DIFFERENTIAL PRESSURE				
OPENING SIZE AREA	ΔPa			
100m²	50Pa			
50m²	100Pa			

PRODUCT SPECIFICATIONS						
SYSTEM	COMPONENT	OMPONENT MATERIALS FRL COLOUR/FINISH				
	FABRIC	1100°C RATED	-/240/-	BOTTOM BAR	SPECIAL ORDER STAINLESS STEEL AVAILABLE	
FIBERSHIELD V	SIDE GUIDES	GALVANISED STEEL		SIDE GUIDES	WILL COME IN GALVANISED FINISH IF COLOUR IS NOT PROVIDED BY CLIENT	
	HEAD BOX & BOTTOM BAR GALVAN	GALVANISED STEEL		HEAD BOX	POWDER COATING IN STANDARD RAL COLOUR	

## FIBERSHIELD 4 - PREMIUM FIRE CURTAIN

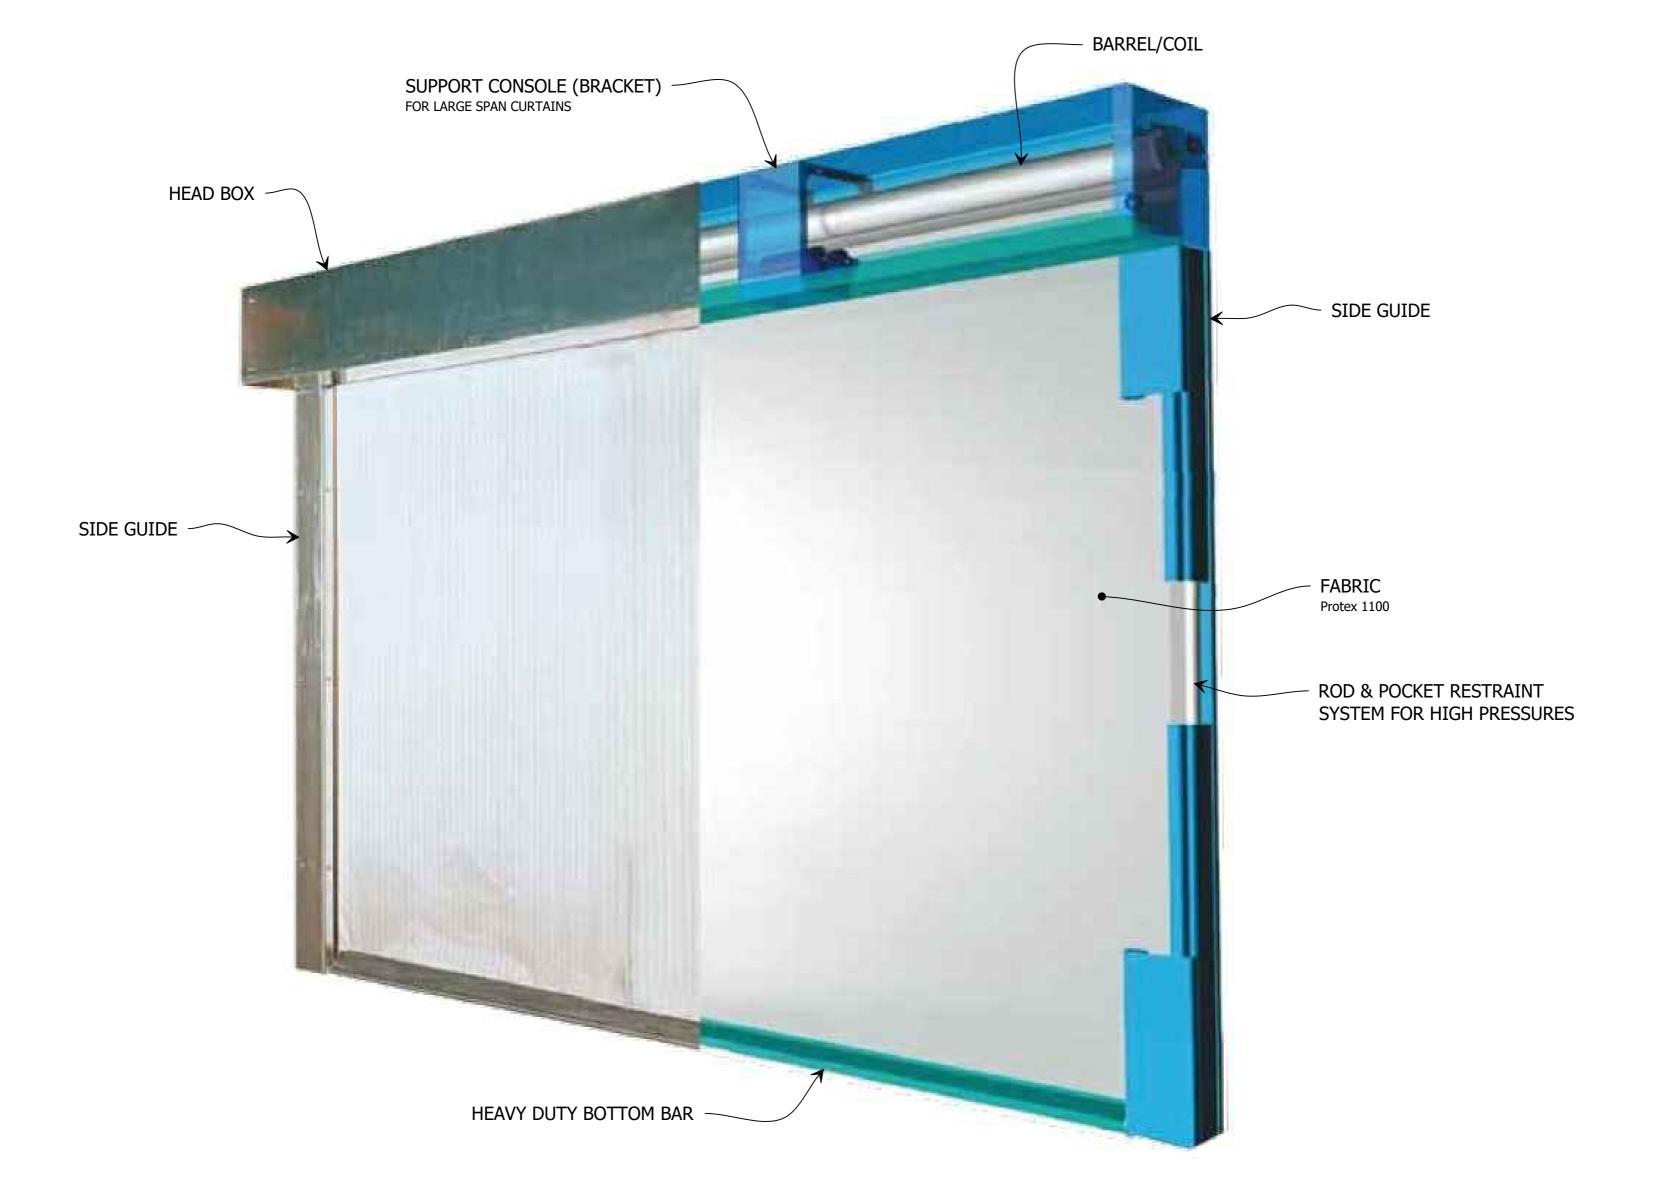

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e <sup>y</sup>	CHK	REASON	DATE
-	AC	FOR INFORMATION	27/05/2020

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FIBERSHIELD 4

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3D INDICATIVE VIEW

SUB SET (CATEGORY)

00 - TEMPLATE


DRAWING NUMBER

FS4-0002

DRAWN BY ISSUE STATUS: ISHTIAQUE ALAM INFORMATION

START DATE 27/05/2020 SCALE AS SHOWN @A2 &

3D VIEW FIBERSHIELD 4 - PREMIUM FIRE CURTAIN

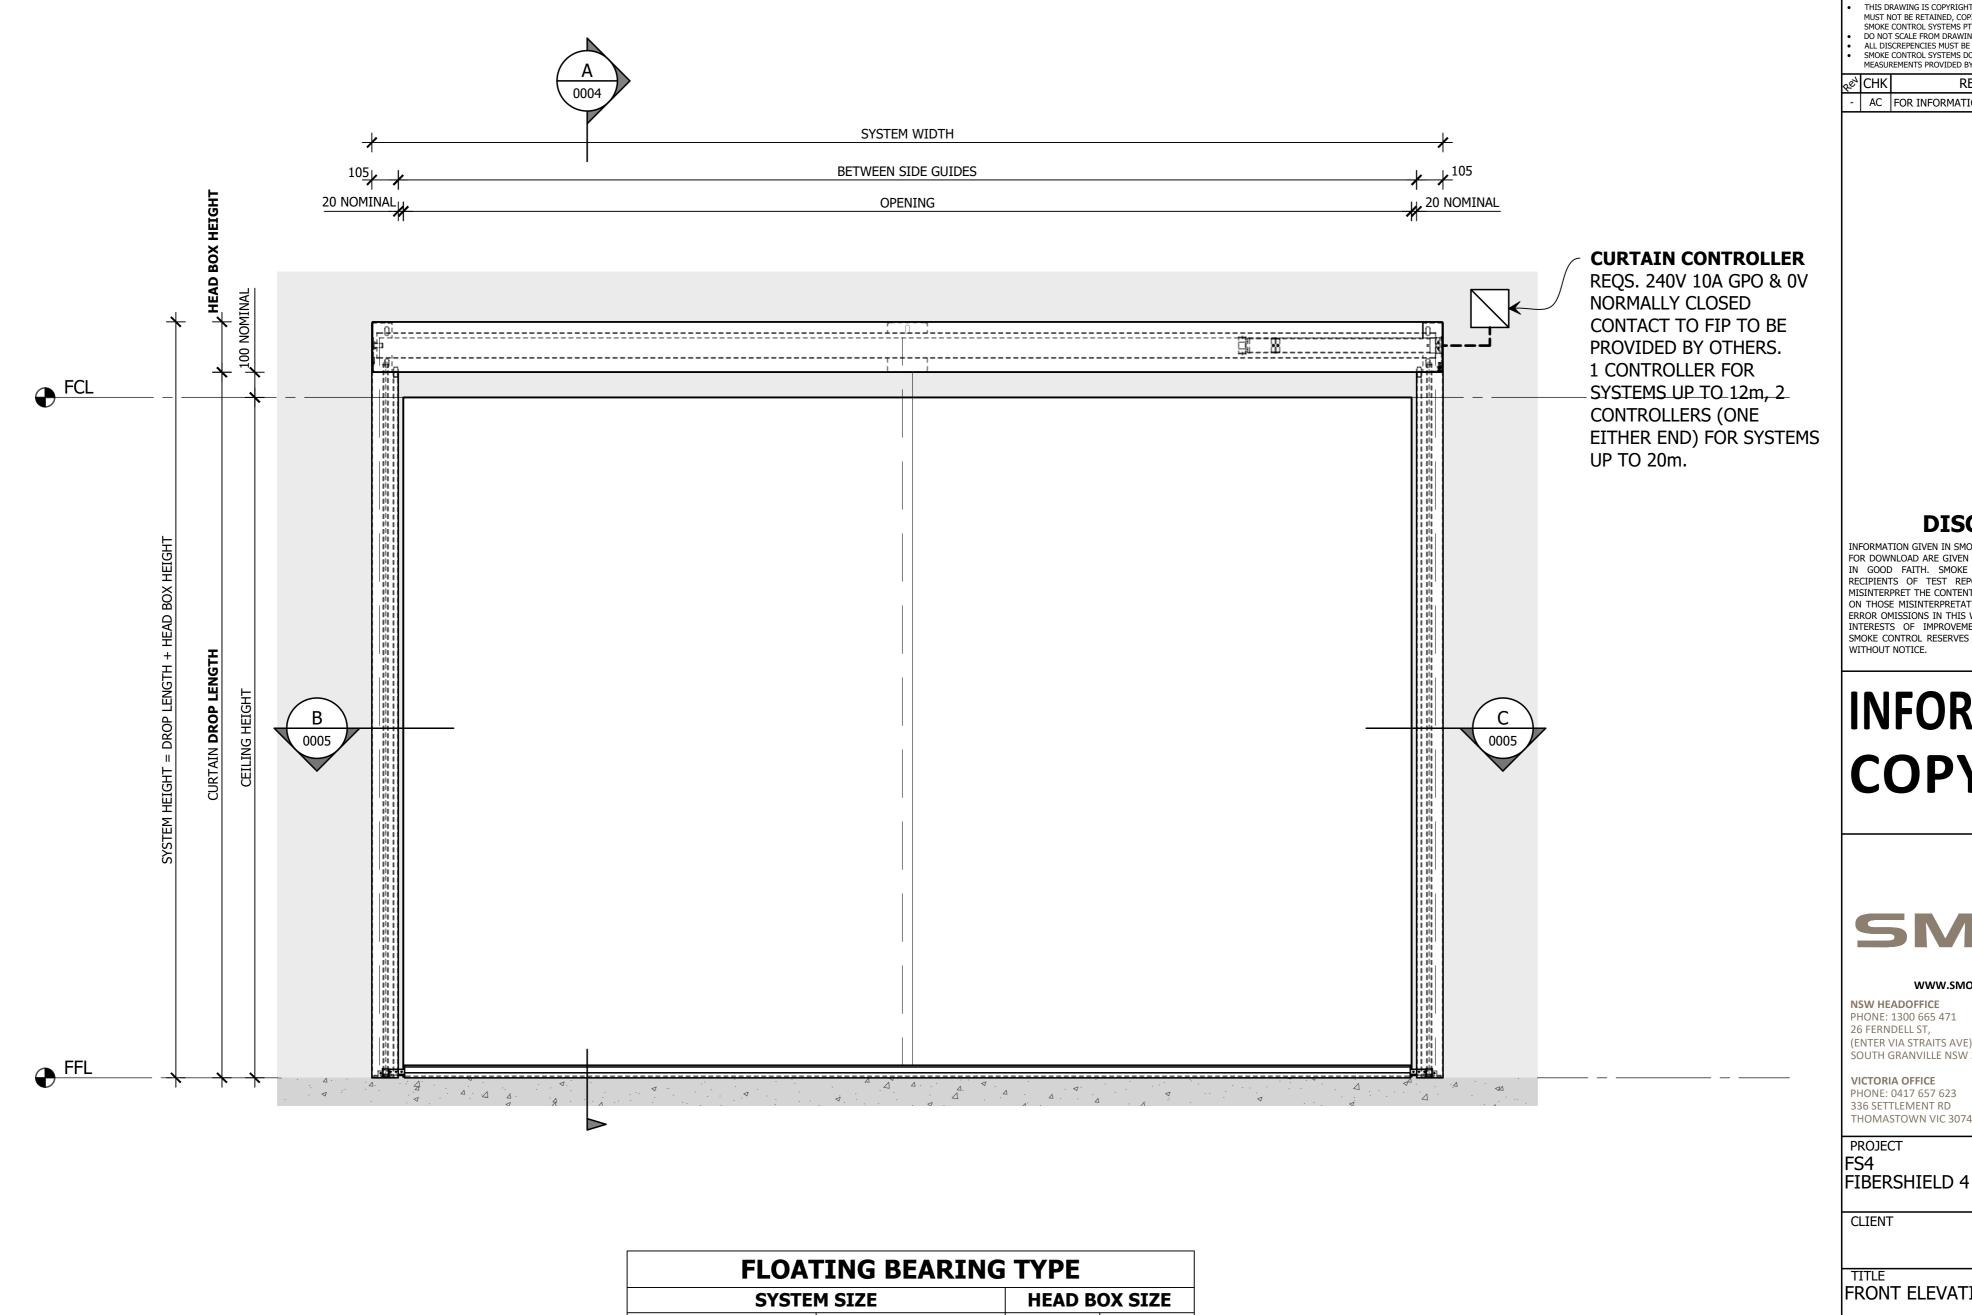

<b>FLOATING BEARING TYPE</b>					
SYSTE	HEAD BOX SIZE				
SYSTEM WIDTH	DROP LENGTH	WIDTH	HEIGHT		
< 30,000	< 3,500	190	200		

NOTE: FOR SYSTEM SIZES OVER SPECIFIED SIZES, PLEASE CONTACT SCS TECHNICAL DEPARTMENT.



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DATE AC FOR INFORMATION 27/05/2020

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PHONE: 0417 657 623 336 SETTLEMENT RD THOMASTOWN VIC 3074

**NEW ZEALAND** PHONE: 09 300 1980 LEVEL 4, 369 QUEEN ST AUCKLAND NZ 1010

FRONT ELEVATION

SUB SET (CATEGORY)

00 - TEMPLATE


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FS4-0003


DRAWN BY ISSUE STATUS: ISHTIAQUE ALAM INFORMATION


START DATE 27/05/2020

SCALE AS SHOWN @A2 &

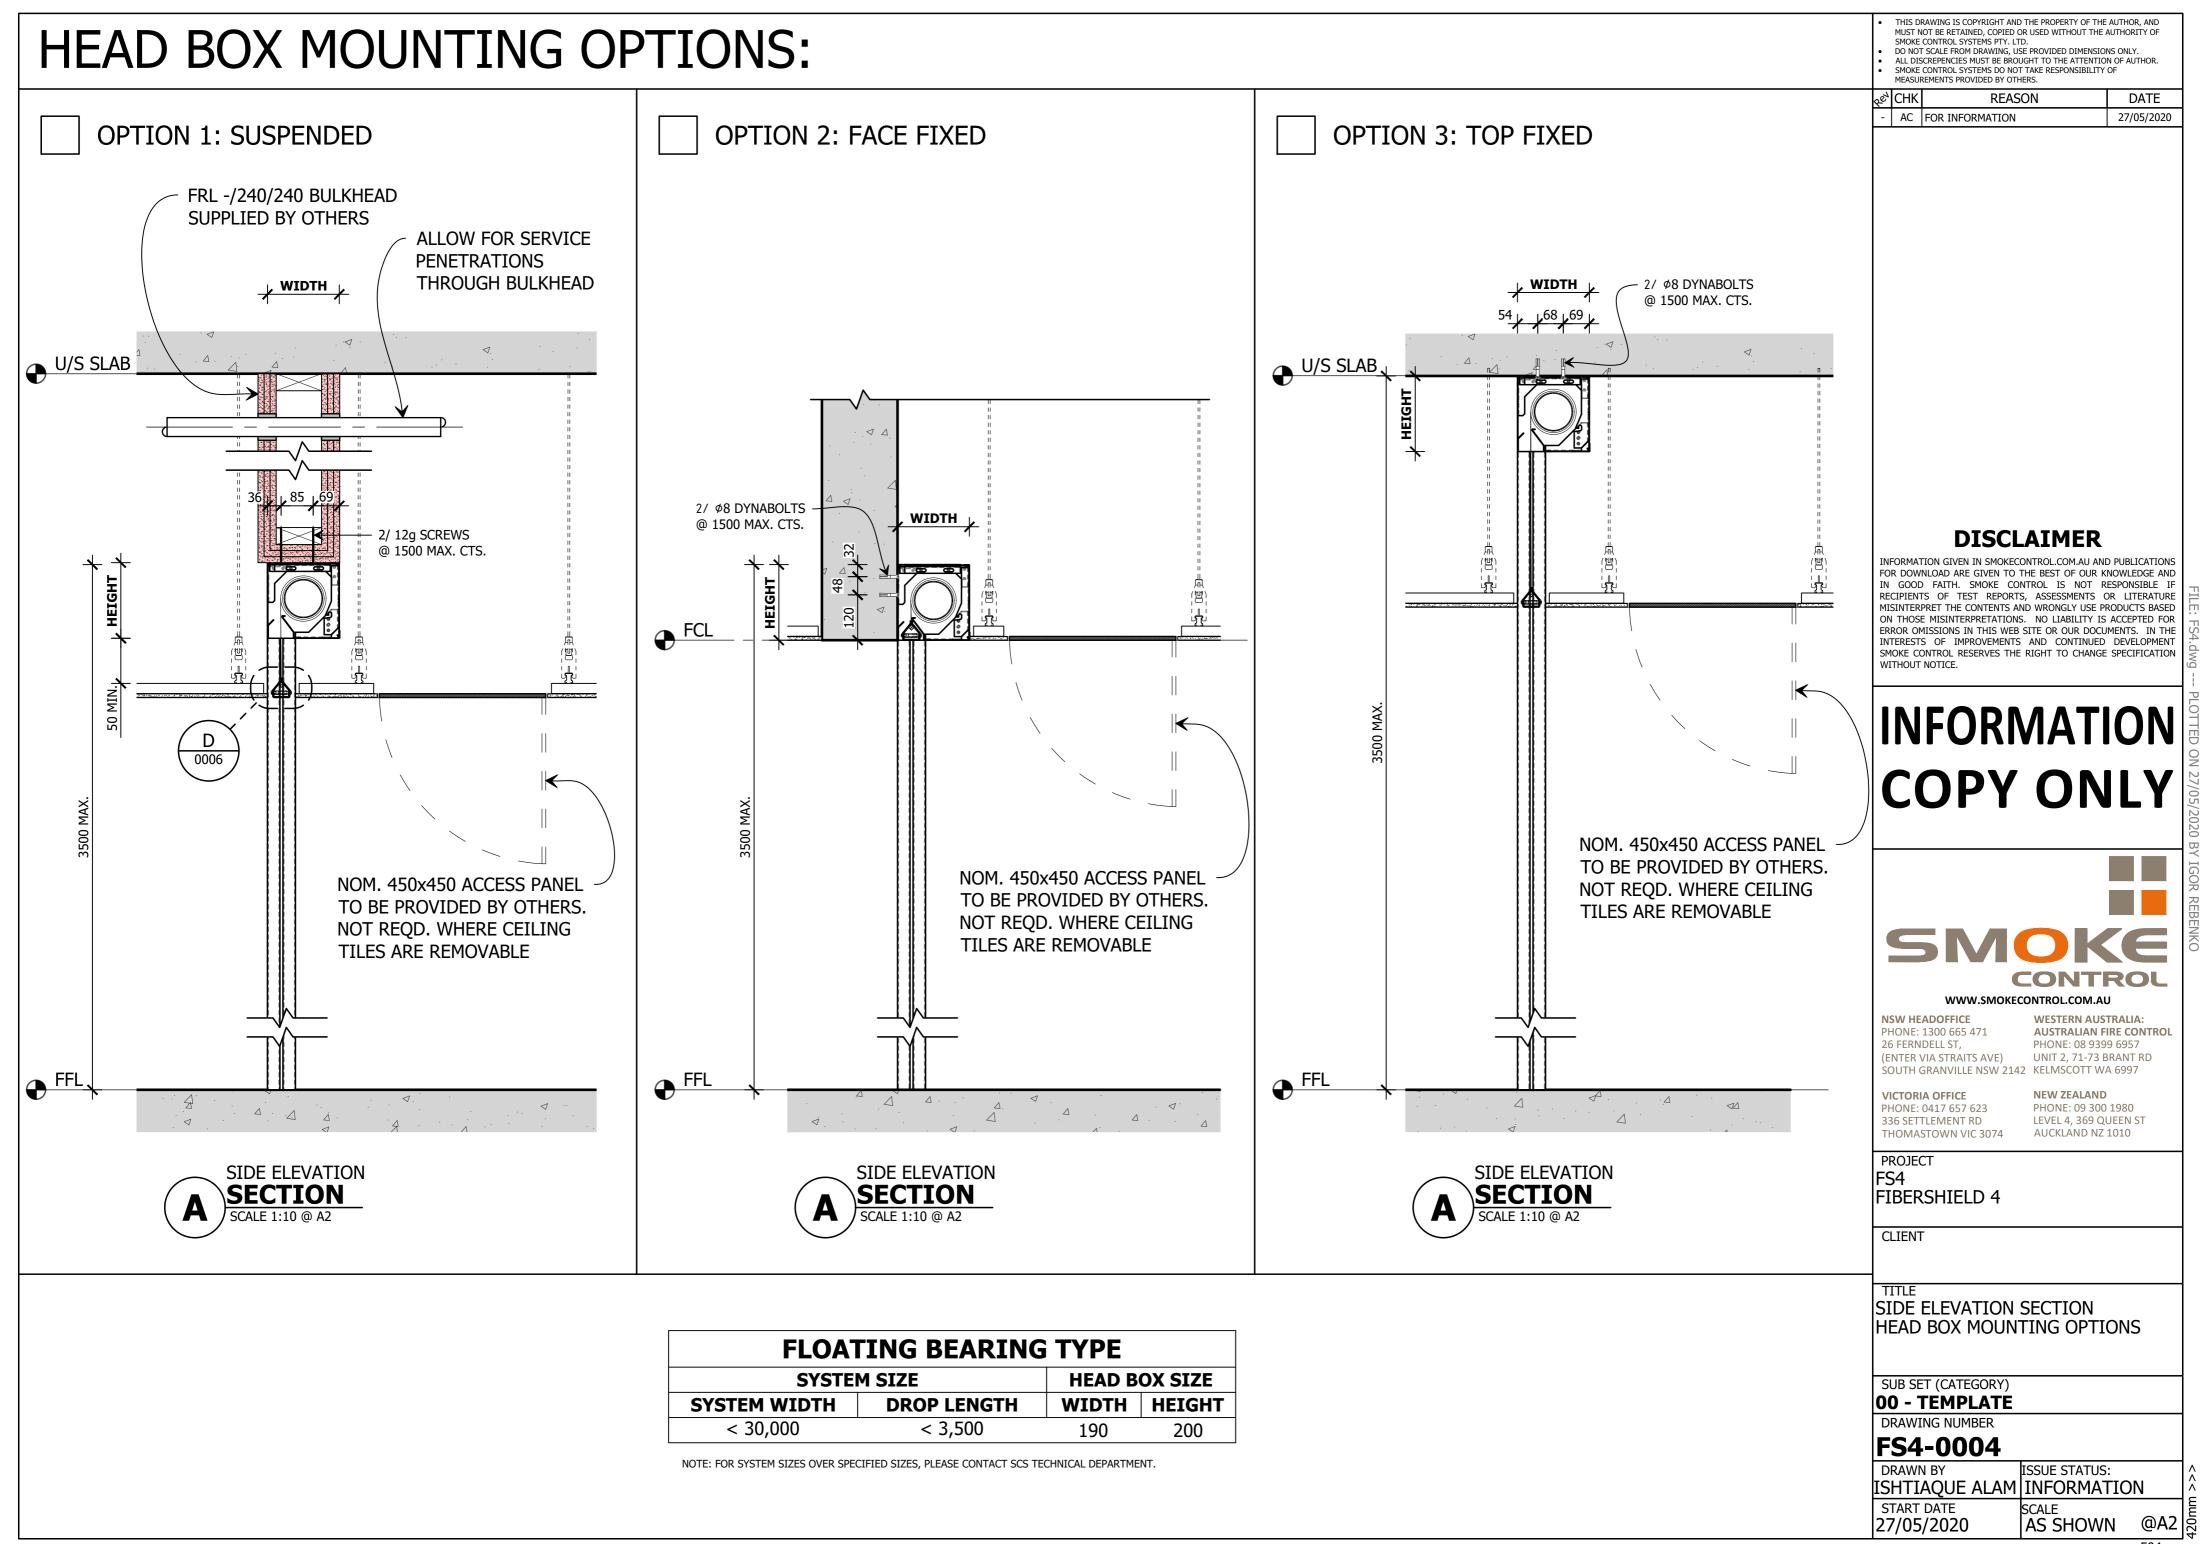

<<< 594mm

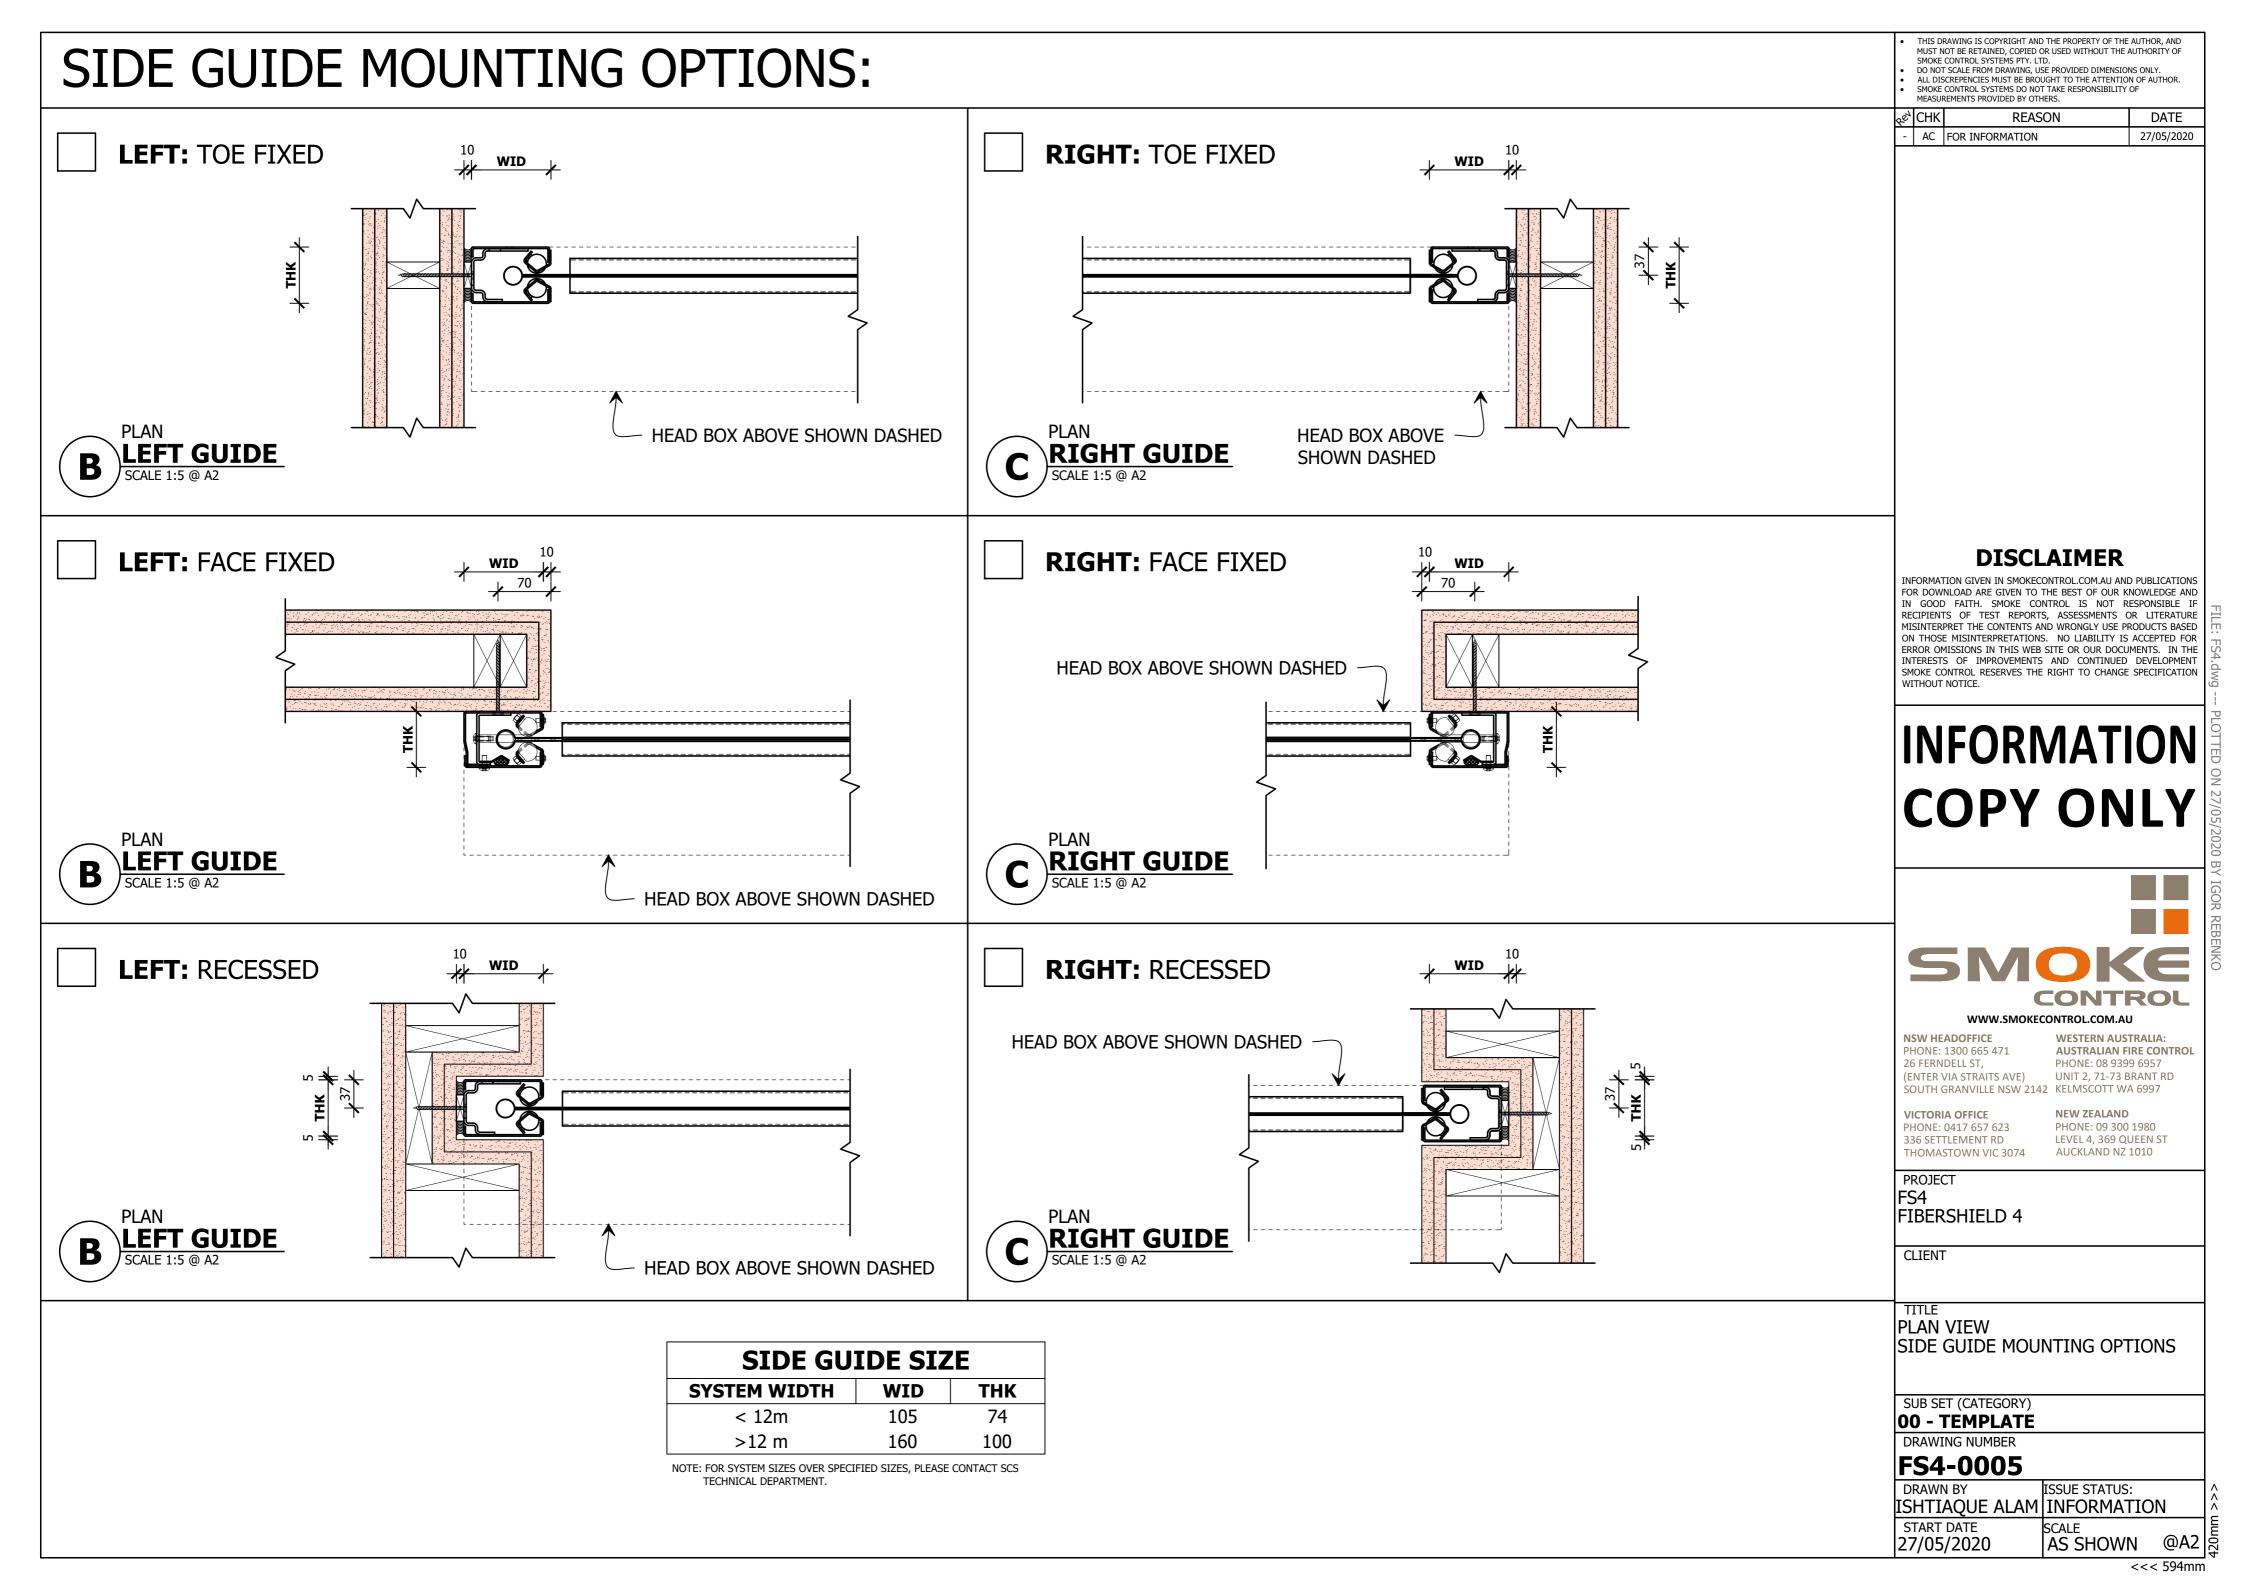

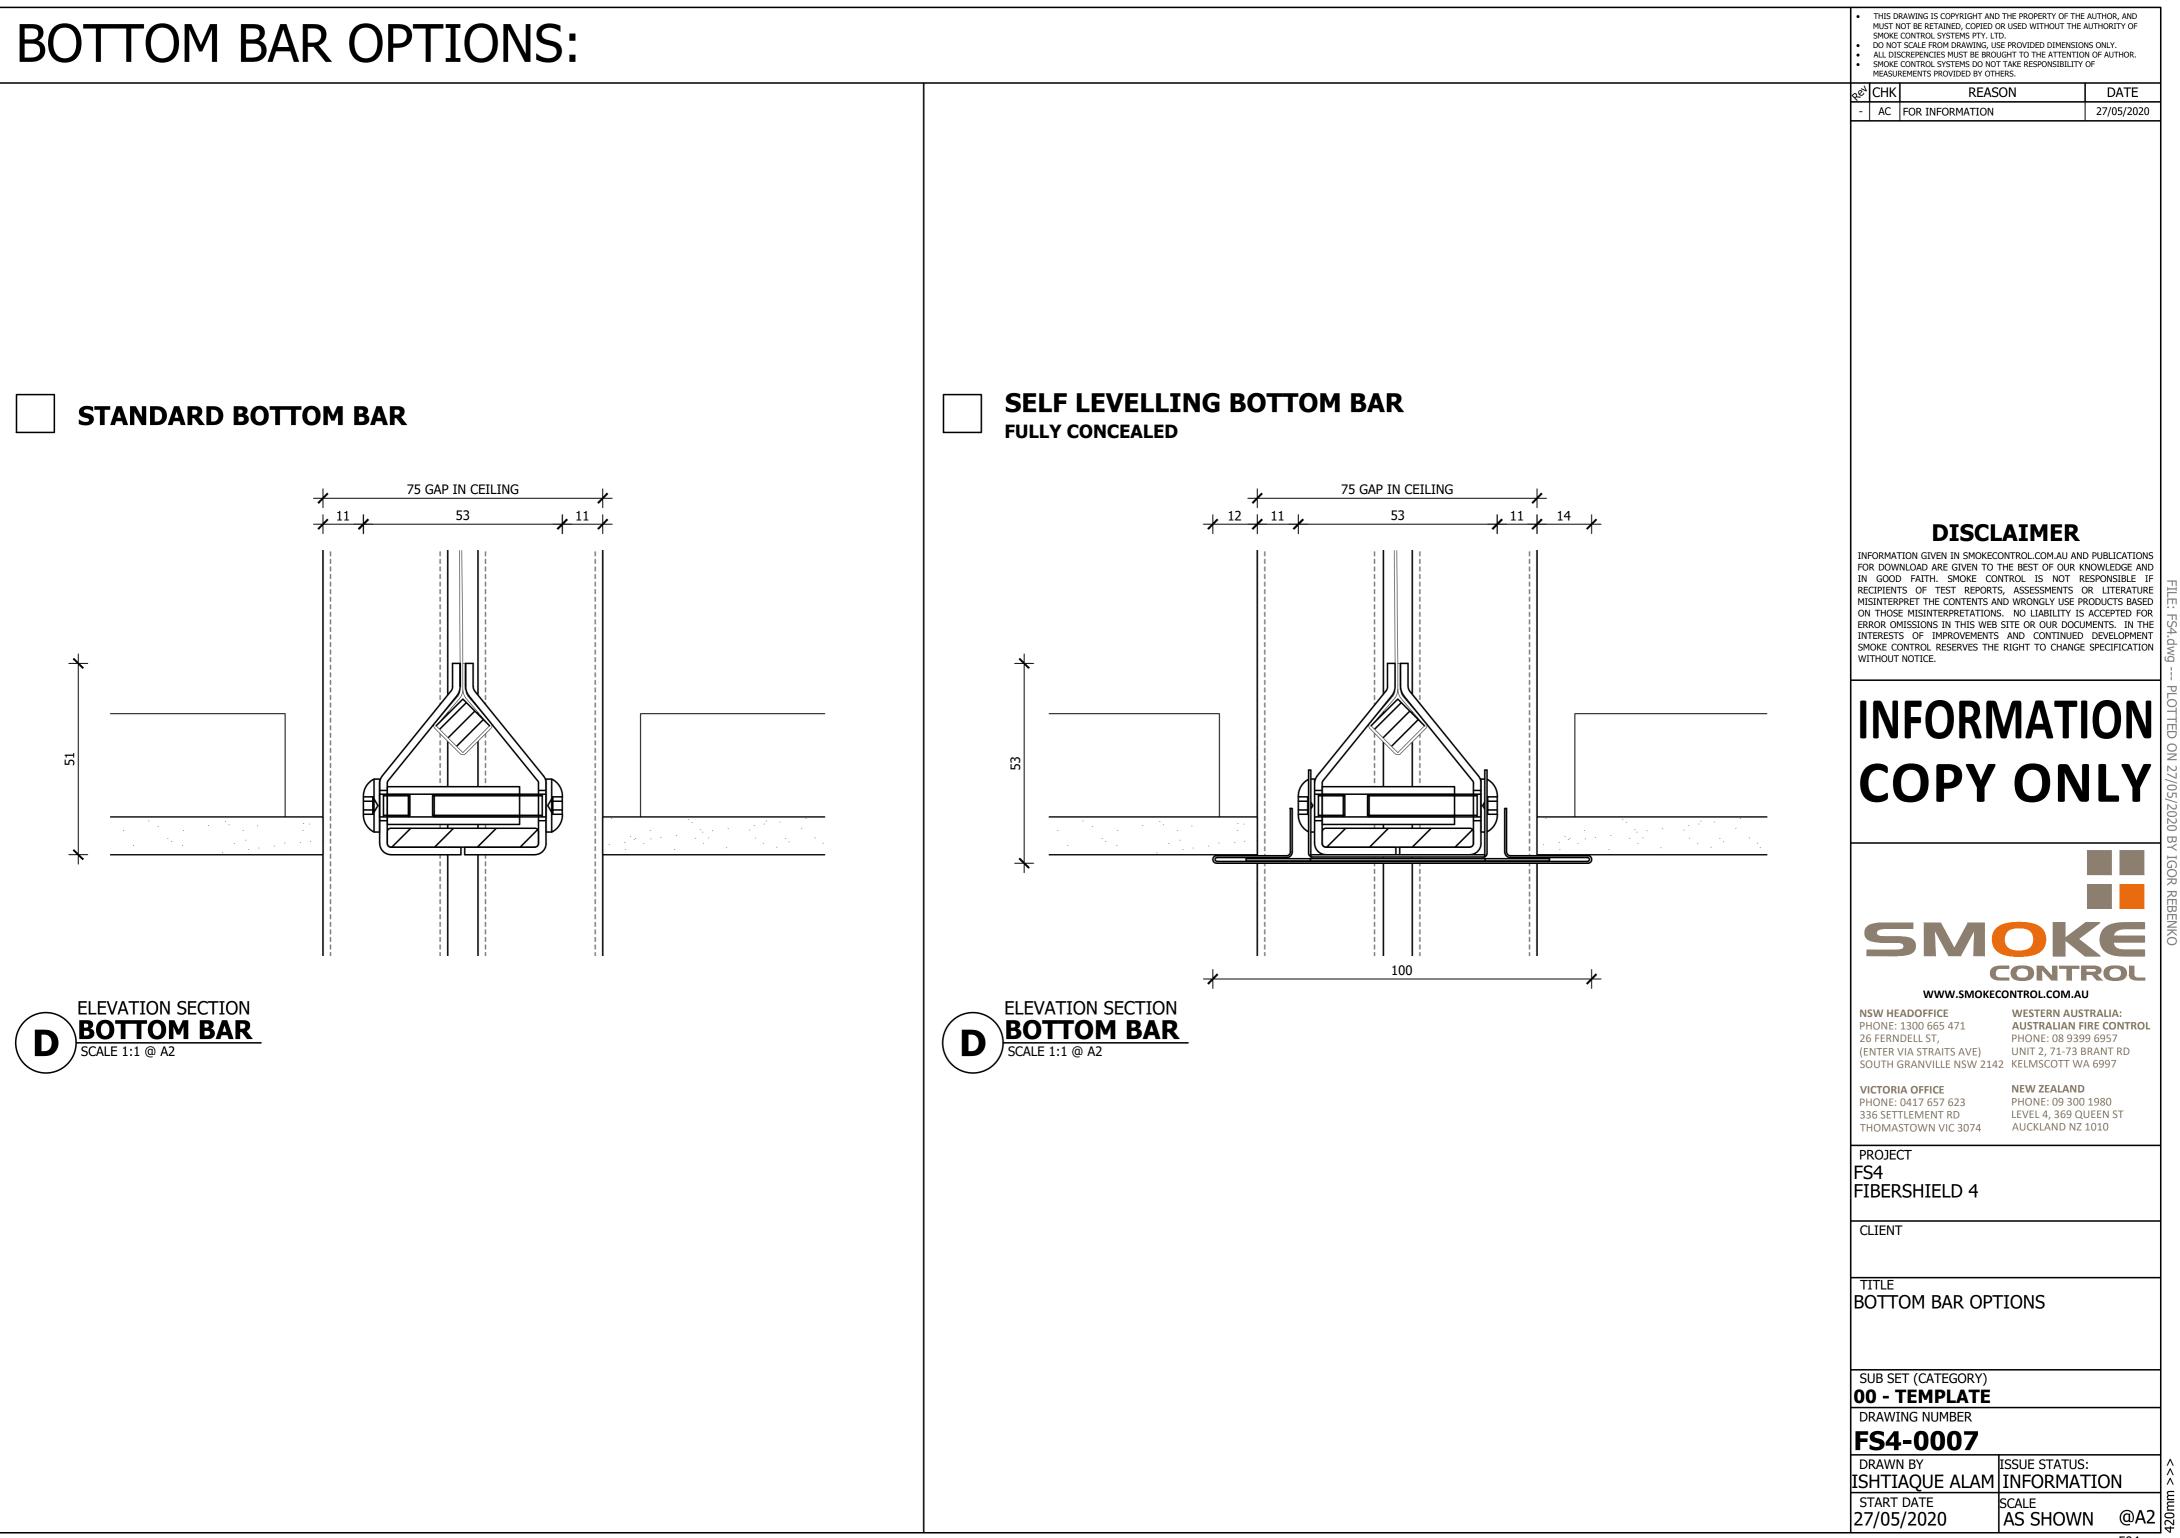

<<< 594mm

## IRS36 OBSTRUCTION SENSORS

PROTECT YOUR ASSET FROM DAMAGE CAUSED BY OBSTRUCTIONS AND ENSURE FULL DEPLOYMENT OF YOUR FIRE AND SMOKE CURTAIN SYSTEM AND THEREFORE FULL COMPLIANCE WITH THE FIRE ENGINEERS REPORT.

ELIMINATE THE REQUIREMENT FOR LINE MARKINGS AND MULTI-COLOURED EXCLUSION ZONES WHICH DETRACT FROM THE INTERIOR DESIGN! THE AUTOMATED IRS40 IS SUITABLE FOR USE ON ALL OF SMOKE CONTROL'S FIRE AND SMOKE CURTAIN SYSTEMS.

OTHER SENSOR SYSTEMS CAN REGISTER SMOKE AS AN OBSTRUCTION AND PREVENT DEPLOYMENT OF THE BARRIER WHEN IT IS ACTUALLY REQUIRED AND CONFLICT WITH THE INTENT OF THE ALTERNATIVE SOLUTION.


THE IRS40 SENSOR SYSTEM IS UNIQUE AND WILL NOT CAUSE THIS CONFLICT, ALLOWING THE BARRIER TO BOTH OPERATE AS INTENDED AND MAINTAIN COMPLIANCE WITH THE ALTERNATIVE SOLUTION AT ALL TIMES.


WHEN A SOLID OBSTRUCTION IS DETECTED UNDER THE DEPLOYMENT AREA OF THE BARRIER, THE SYSTEM WILL WAIT FOR A SPECIFIED TIME DELAY, THEN AN AUDIO-VISUAL SIGNAL WILL NOTIFY THE OCCUPANTS THAT THE OBSTRUCTION MUST BE REMOVED. THE SYSTEM AUTOMATICALLY RESETS ONCE THE OBSTRUCTION IS REMOVED FROM THE DEPLOYMENT AREA.


SCALE 1:10 @ A2

**DIMENSIONS:** 230mm (W), 70mm (H), 44mm (D)

**IP RATING:** IP54

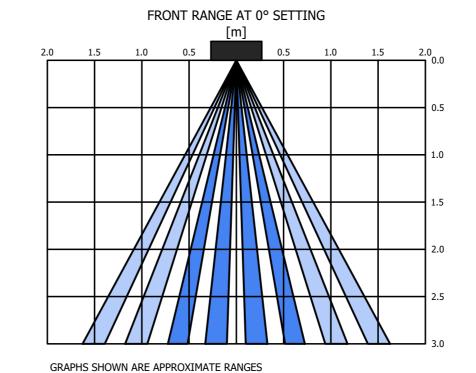

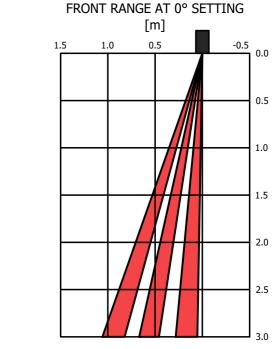

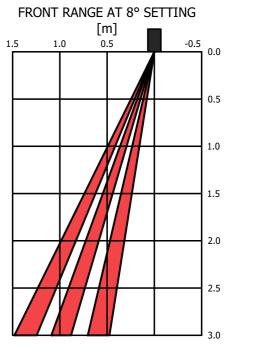

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PROJECT FIBERSHIELD 4

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OBSTRUCTION SENSORS

SUB SET (CATEGORY) 00 - TEMPLATE

DRAWING NUMBER

FS4-0008

DRAWN BY ISSUE STATUS: ISHTIAQUE ALAM INFORMATION

START DATE SCALE 27/05/2020

SENSOR RANGE OVERLAP FIRE CURTAIN ABOVE **OBSTRUCTION SENSOR** SENSOR RANGE SHOWN HATCHED IN BLUE REFLECTED PLAN OBSTRUCTION SENSOR LAYOUT

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> AS SHOWN @A2 5 <<< 594mm